



What: Corridor # 290 - Flooring Abatement

Where: 2nd Floor East Corridor #290

Start Date: 12/14/20

Impact: No Access to rooms off corridor #290 – See attached plan for corridor shutdown

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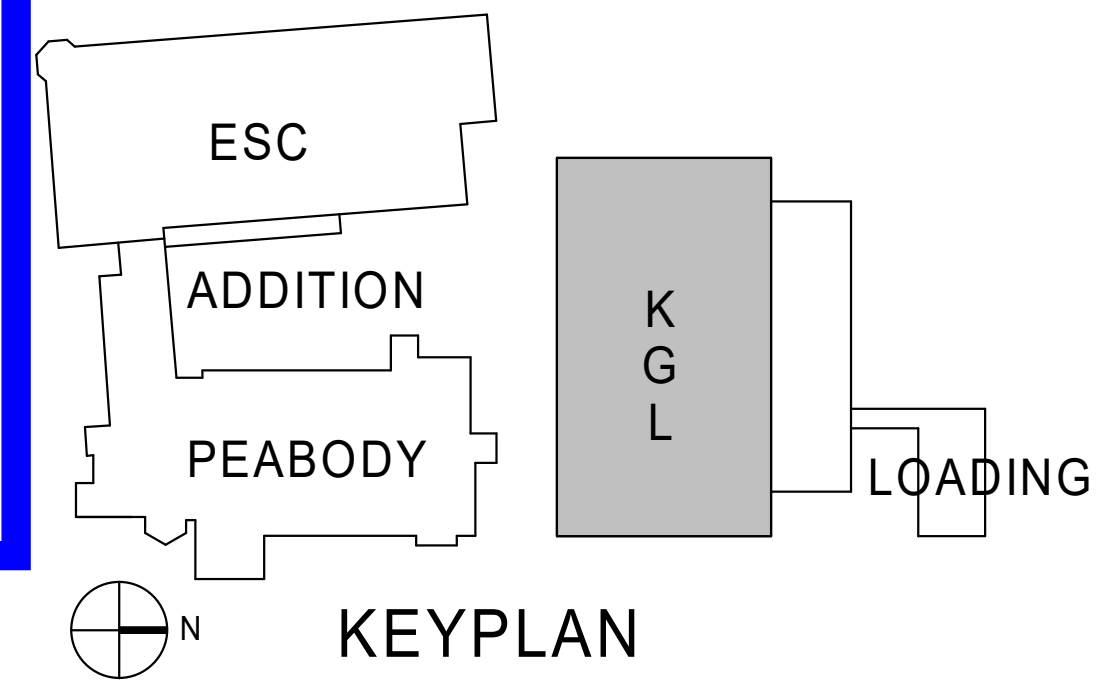
GENERAL NOTES - FLOOR PLAN

- DIMENSIONS NOTED AS "EQUAL" OR "EQ" WITHIN A ROOM REFER TO A DISTANCE RELATIONSHIP CONTAINED ONLY IN THAT ROOM AT AN OPPOSING OR PARALLEL WALL UNLESS NOTED OTHERWISE.
- TYPICAL CODE-REQUIRED MANEUVERING CLEARANCES FOR ACCESSIBILITY AT DOORS IS SHOWN IN THE CODE PLANS LEGEND. THE REQUIRED MANEUVERING CLEARANCES FOR EACH DOOR ARE SHOWN ON THE FLOOR PLAN OR LAYOUT DRAWINGS. THE CONTRACTOR SHALL BE FULLY RESPONSIBLE TO COORDINATE THE REQUIREMENT FOR MANEUVERING CLEARANCES WITH SUBCONTRACTORS, VENDORS AND INSTALLERS AND VERIFY THAT THE INSTALLED WORK WILL PROVIDE THE REQUIRED MANEUVERING CLEARANCES. REPORT ALL DEVIATIONS FROM THE MANEUVERING CLEARANCE REQUIREMENTS TO THE ARCHITECT. DO NOT PROCEED WITH THE INSTALLATION OF ANY WORK ENCRANCHING ON THE REQUIRED MANEUVERING CLEARANCES UNTIL THE ISSUE HAS BEEN RESOLVED WITH THE ARCHITECT. MAKE NECESSARY CORRECTIONS.
- DIMENSIONS SHOWN ON ARCHITECTURAL FLOOR PLANS AND ENLARGED PLAN DETAILS ARE TO FACE OF STUD, TO FACE OF MASONRY OR TO CENTER LINE OF COLUMN UNLESS OTHERWISE NOTED.
- ENSURE FINISH SURFACES ARE FLUSH AND SEAMLESS WHERE PARTITIONS AND/OR FURRING ARE COPLANAR.
- ALL PIPING, CONDUITS AND RELATED MECHANICAL AND ELECTRICAL ITEMS SHALL BE CONCEALED WITHIN PARTITION WALL ASSEMBLY IN FINISHED AREA, U.N.O.
- PROVIDE BACKING/BLOCKING TO SUPPORT ALL WALL MOUNTED ITEMS.
- ALL MECHANICAL PADS TO BE 4" HIGH MINIMUM. U.N.O. SIZE OF PAD TO BE VERIFIED BY CONTRACTOR.
- PITCH SLABS (AND OTHER FLOORS) TO FLOOR DRAINS, TYP.



No Access Abatement Start Date: 12/14/20
Access Reopens - 12/21/20

KGL 2nd Floor Corridor 290 East Side Flooring Abatement Work
Yale Kline Geology Laboratory Code Upgrades Project
New Haven, CT
Turner Project No. 201026
Data Date: December 2, 2020
By: VJH



NO.	DATE	REVISION

BID DOCUMENTS

PROJECT NAME
Yale Kline Geology Laboratory Code Upgrades

BUILDING NAME & ADDRESS
YALE KLINE GEOLOGY LABORATORY
215 WHITNEY AVE, NEW HAVEN, CT 06511

PROJECT NUMBER
17081006

DRAWING TITLE
SECOND FLOOR PLAN

SCALE 1/8" = 1'-0"	DRAWN BY ECS
CAD FILE NAME 17081006 A1.20K	DATE 6/12/2020
DRAWING NUMBER	

A1.20K



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